BLUELINE

25 CENTRAL WAY, SUITE 400. KIRKLAND, WA 98033 P: 425.216.4051 F: 425.216.4052 WWW.THEBLUELINEGROUP.COM

AS NOTED

Brett K Pudists, Pe PROJECT ENGINEER. NICK RASOR, PE

AARON C LANCE

SITE ADDRESS: TAX ACCOUNT NUMBER: GROSS SITE AREA: GROSS FLOOR AREA: NUMBER OF LOTS PROPOSED: PROPOSED USE: MINIMUM LOT SIZE ALLOWED: SETBACKS:

LOT COVERAGE:

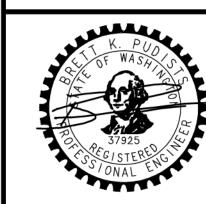
BUILDING HEIGHT:

2174502425 2.88 ACRES (125,315.52 SF)

30' MAX ABOVE ABE

SINGLE FAMILY 8,400 SF FRONT 20' (F), REAR 25' (R), SIDE 5' (S) (BUT 2 SIDE YARDS MUST EQUAL 15') ROW AND VEHICULAR ACCESS EASEMENT 10 40% MAX (LOT SLOPE LESS THAN 15%)

UNDERGROUND UTILITIES ARE SHOWN IN THE APPROXIMATE LOCATION. THERE IS NO GUARANTEE THAT ALL UTILITY LINES ARE SHOWN, OR THAT THE LOCATION, SIZE AND MATERIAL IS ACCURATE. THE CONTRACTOR SHALL UNCOVER ALL INDICATED PIPING WHERE CROSSING, INTERFERENCES, OR CONNECTIONS OCCUR PRIOR TO TRENCHING OR EXCAVATION FOR ANY PIPE OR STRUCTURES, TO DETERMINE ACTUAL LOCATIONS, SIZE AND MATERIAL. THE CONTRACTOR SHALL MAKE THE APPROPRIATE PROVISION FOR PROTECTION OF SAID FACILITIES. THE CONTRACTOR SHALL NOTIFY ONE CALL AT 8-1-1 (WASHINGTON811.COM) AND ARRANGE FOR FIELD LOCATION OF EXISTING FACILITIES BEFORE CONSTRUCTION.



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13-118 SHEET NAME: CV-01

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SEWER MANHOLE

SEWER CLEANOUT

✓ PIPE FLOW

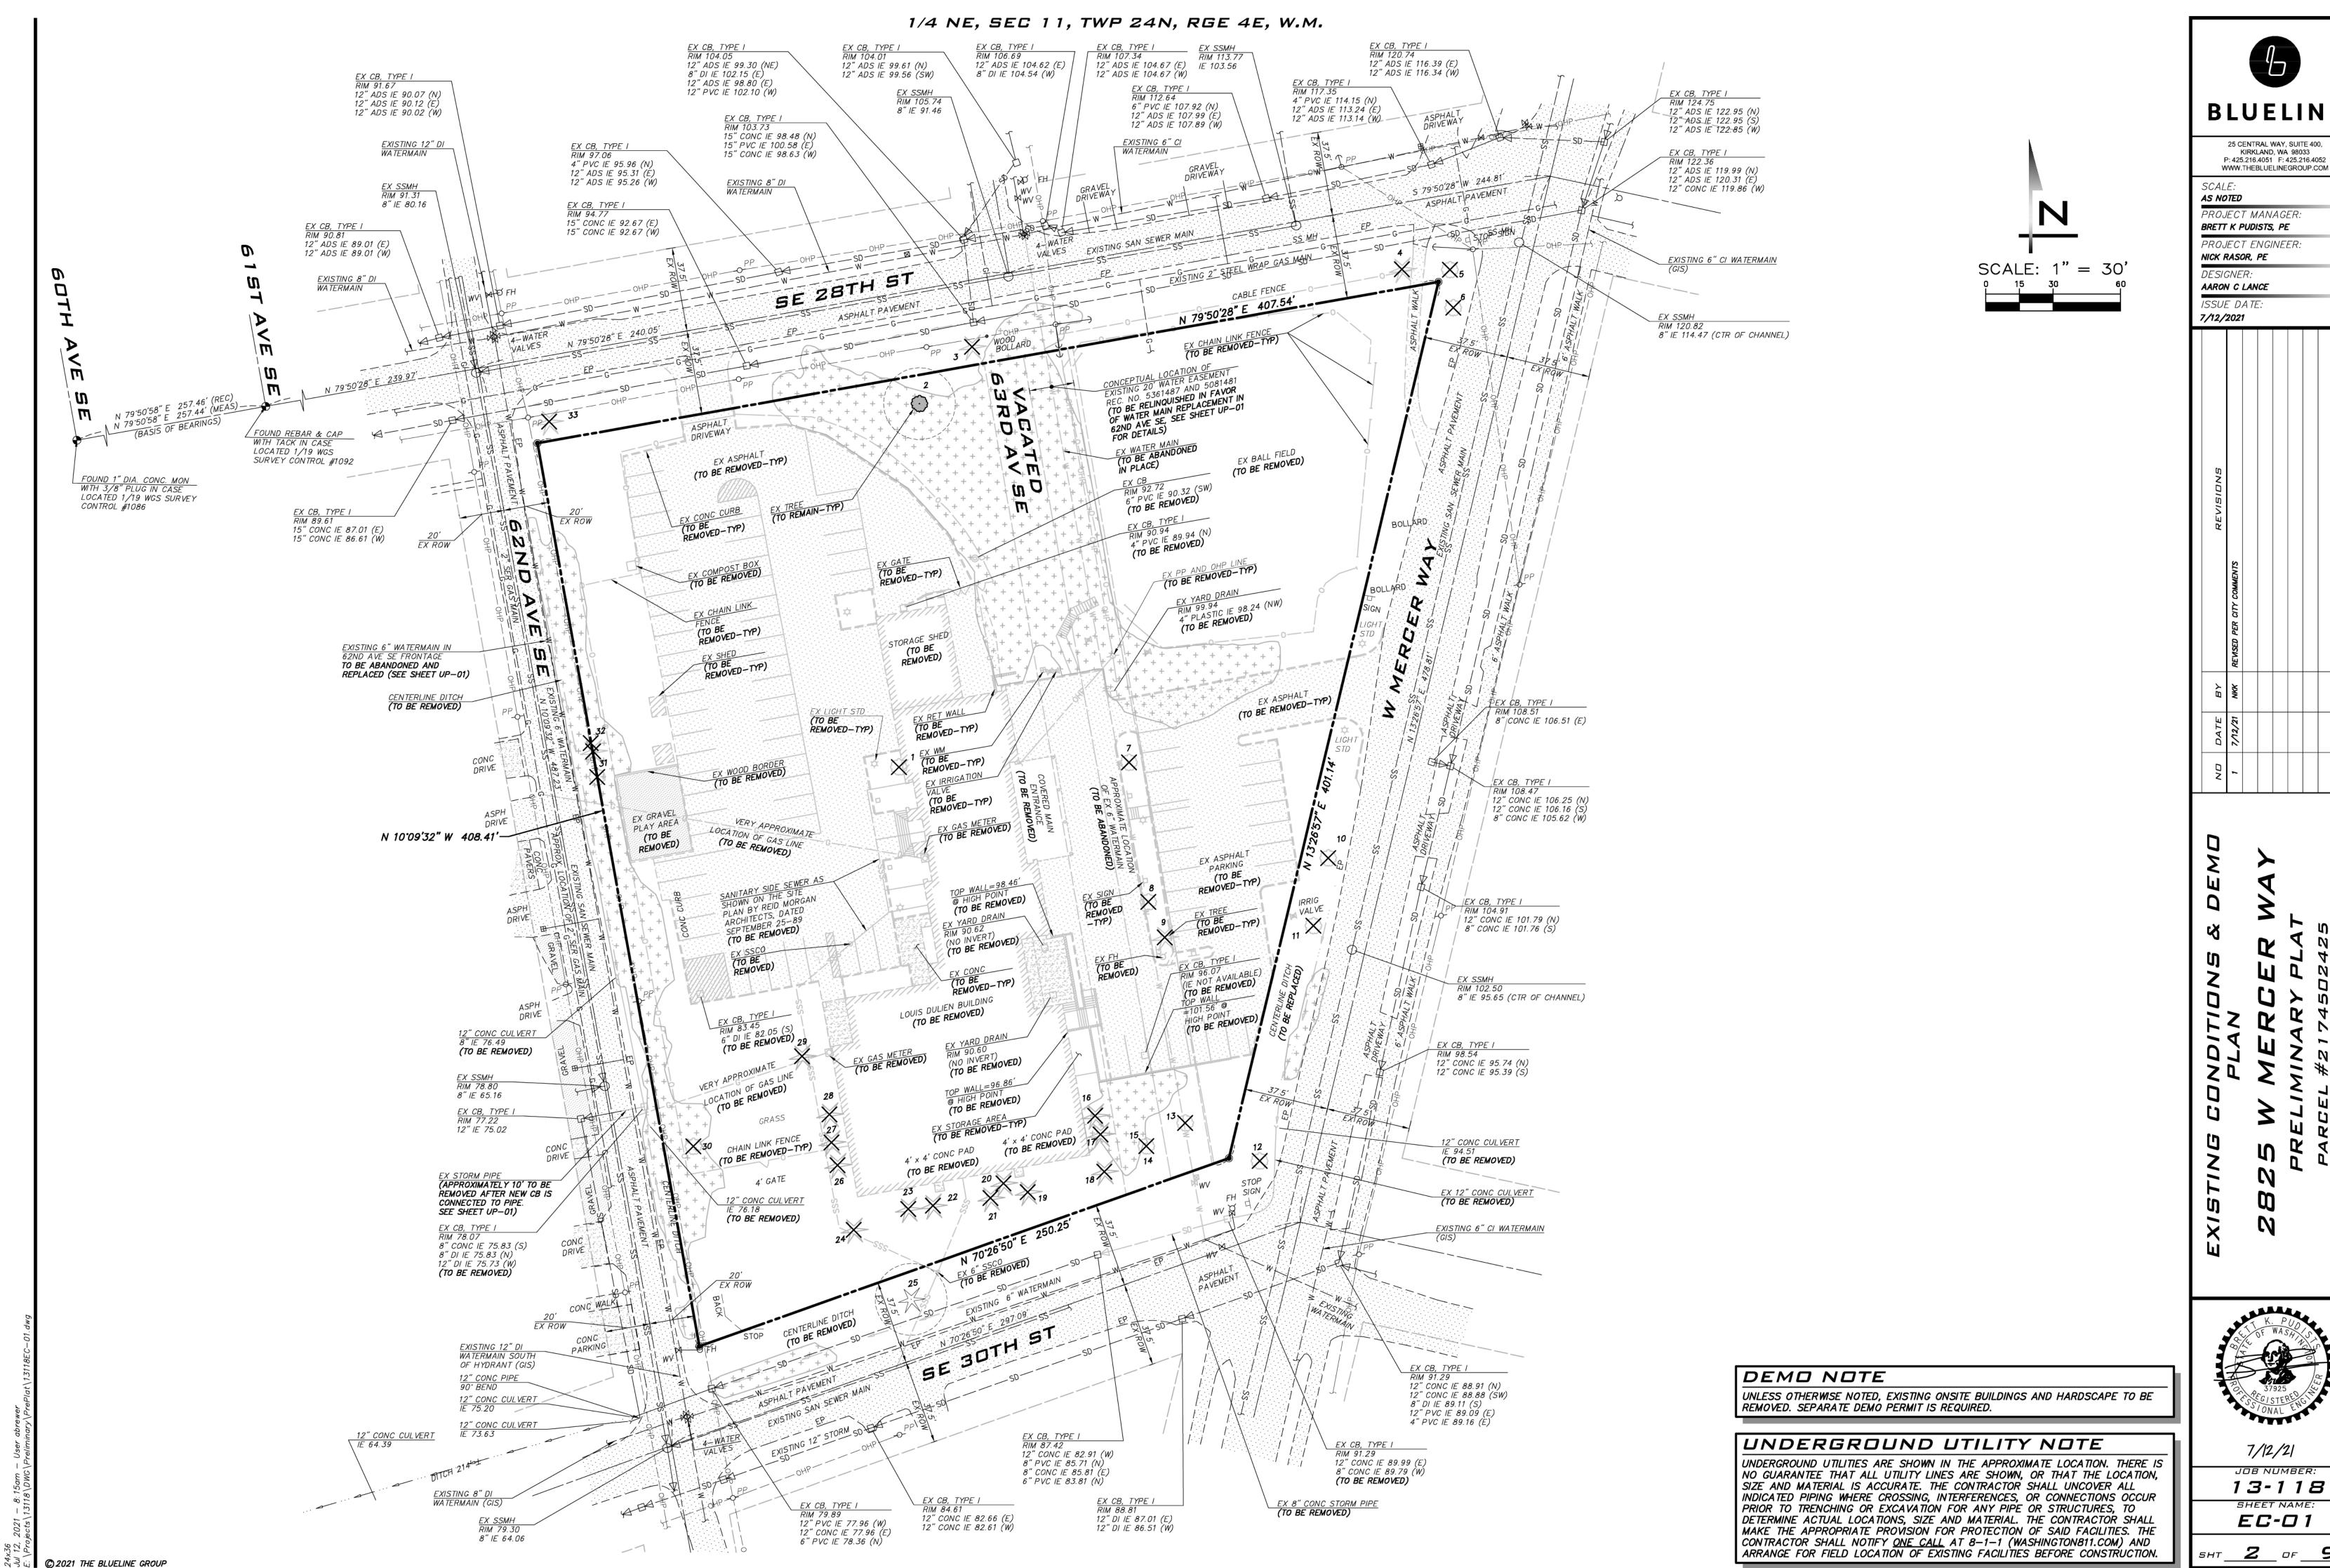
AIR/VAC RELEASE VALVE

TEE W/ CONC BLOCKING

↓ BEND W/ CONC BLOCKIN

BLOW OFF

]H[GATE VALVE





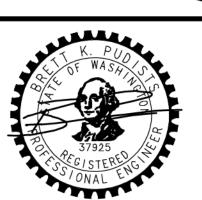
25 CENTRAL WAY, SUITE 400, KIRKLAND, WA 98033 P: 425.216.4051 F: 425.216.4052

AS NOTED

PROJECT MANAGER: BRETT K PUDISTS, PE

PROJECT ENGINEER: NICK RASOR, PE

AARON C LANCE ISSUE DATE:

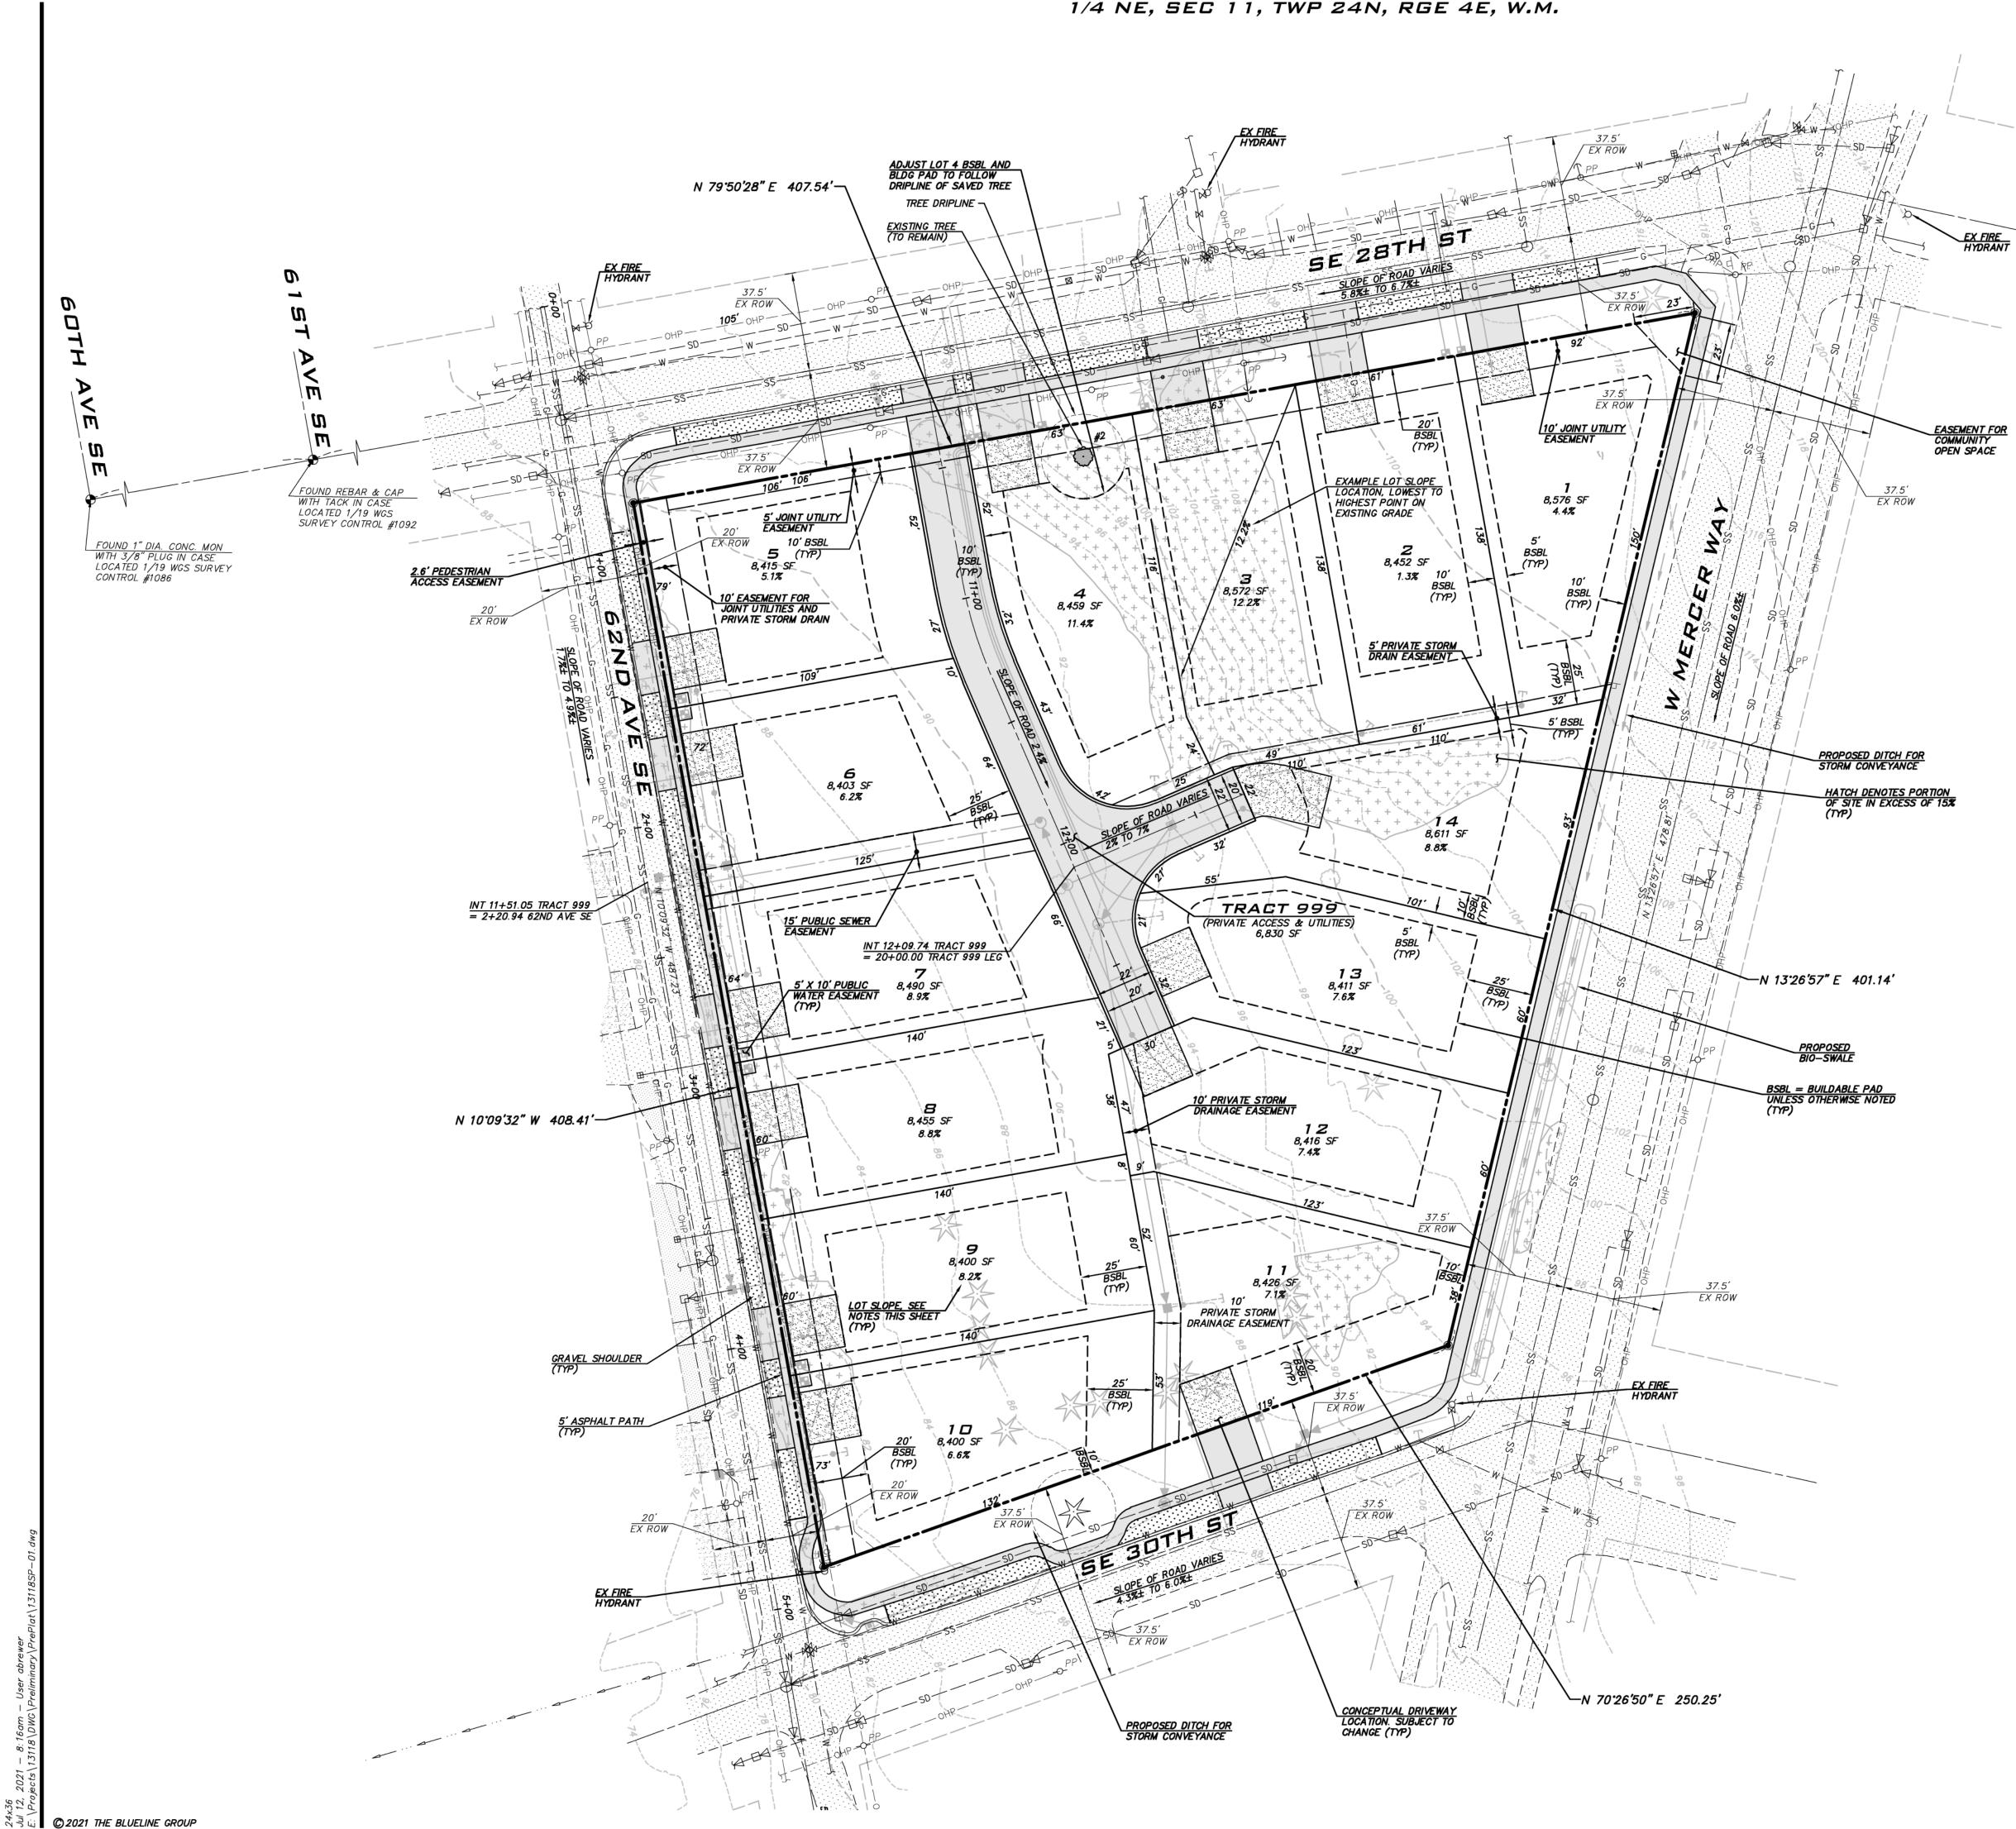


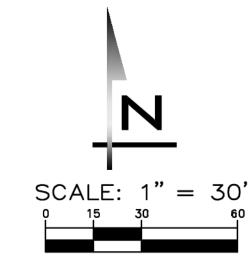
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13-118

SHEET NAME: EC-01

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				PORTION OF
LOT NO.	LOT AREA (SF)	LOT COVERAGE (SF)*	LANDSCAPING AREA (SF)*	LANDSCAPING AREA THAT CAN BE HARDSCAPE (SF)**
1	8,576	3,430	5,146	772
2	8,452	3,381	5,071	761
3	8,572	3,429	5,143	771
4	8,459	3,384	5,075	761
5	8,415	3,366	5,049	<i>7</i> 57
6	8,403	3,361	5,042	<i>75</i> 6
7	8,490	3,396	5,094	764
8	8,455	3,382	5,073	761
9	8,400	3,360	5,040	<i>75</i> 6
10	8,400	3,360	5,040	<i>75</i> 6
11	8,426	3,370	5,056	<i>75</i> 8
12	8,416	3,366	5,050	<i>7</i> 57
13	8,411	3,364	5,047	<i>7</i> 57
14	8,611	3,444	5,167	775

**REQUIRED LANDSCAPING AREA SHALL CONSIST OF SOFTSCAPE IMPROVEMENTS, EXCEPT WHERE USED FOR HARDSCAPE IMPROVEMENTS. 9% OF THE LOT AREA MAY CONSIST OF

FIRE SPRINKLERS

NEW SINGLE FAMILY RESIDENCES REQUIRE A MINIMUM OF 13D SPRINKLER SYSTEM.

LOT SLOPES

DENOTES AREAS OF SLOPE ≥ 15%.

ELEVATION) / HORIZONTAL DISTANCE) X 100

SLOPE OF LOT = X.X% ((HIGHEST LOT ELEVATION - LOWEST LOT

CRITICAL AREAS NOTE

NO CRITICAL AREAS WERE IDENTIFIED ON SITE.

NEAREST FIRE HYDRANT EXISTING FIRE HYDRANTS ARE LOCATED NEAR EACH STREET INTERSECTION AND HAVE BEEN LABELED FOR CONVENIENCE.

BUILDING HEIGHTS

- PROPOSED BUILDINGS WILL BE DESIGNED IN THE FUTURE AS PART OF THE BUILDING PERMIT PROCESS.
- AVERAGE BUILDING ELEVATION GRADE POINTS TO BE DETERMINED BASED ON PROPOSED BUILDINGS BY OTHERS.

NOTES

- SEE LEGEND ON SHEET CV-01.
- REFER TO SHEET EC-01 FOR EXISTING FEATURES THAT WILL BE REMOVED.
- REFER TO SHEET GP-01 FOR PRELIMINARY GRADING PLAN.
- REFER TO SHEET UP-01 FOR PRELIMINARY UTILITY PLAN.
- SEE SHEET RS-01 FOR ROAD SLOPES AND CROSS SECTIONS.
- SEE SHEET TR-01 FOR TREE NUMBERS AND RETENTION SUMMARY.
- DIRECT VEHICULAR ACCESS TO W MERCER WAY IS PROHIBITED.

UNDERGROUND UTILITY NOTE

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BLUELINE 25 CENTRAL WAY, SUITE 400, KIRKLAND, WA 98033 P: 425.216.4051 F: 425.216.4052 WWW.THEBLUELINEGROUP.COM

AS NOTED PROJECT MANAGER:

BRETT K PUDISTS, PE PROJECT ENGINEER:

NICK RASOR, PE AARON C LANCE

ISSUE DATE: 7/12/2021

7/12/21

13-118 SHEET NAME: SP-01

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25 CENTRAL WAY, SUITE 400, KIRKLAND, WA 98033 P: 425.216.4051 F: 425.216.4052 WWW.THEBLUELINEGROUP.COM

AS NOTED

PROJECT MANAGER: BRETT K PUDISTS, PE

PROJECT ENGINEER:

NICK RASOR, PE AARON C LANCE

ISSUE DATE:

7/12/2021

7/12/21

13-118 SHEET NAME: GP-01

PRELIMINARY EARTHWORK

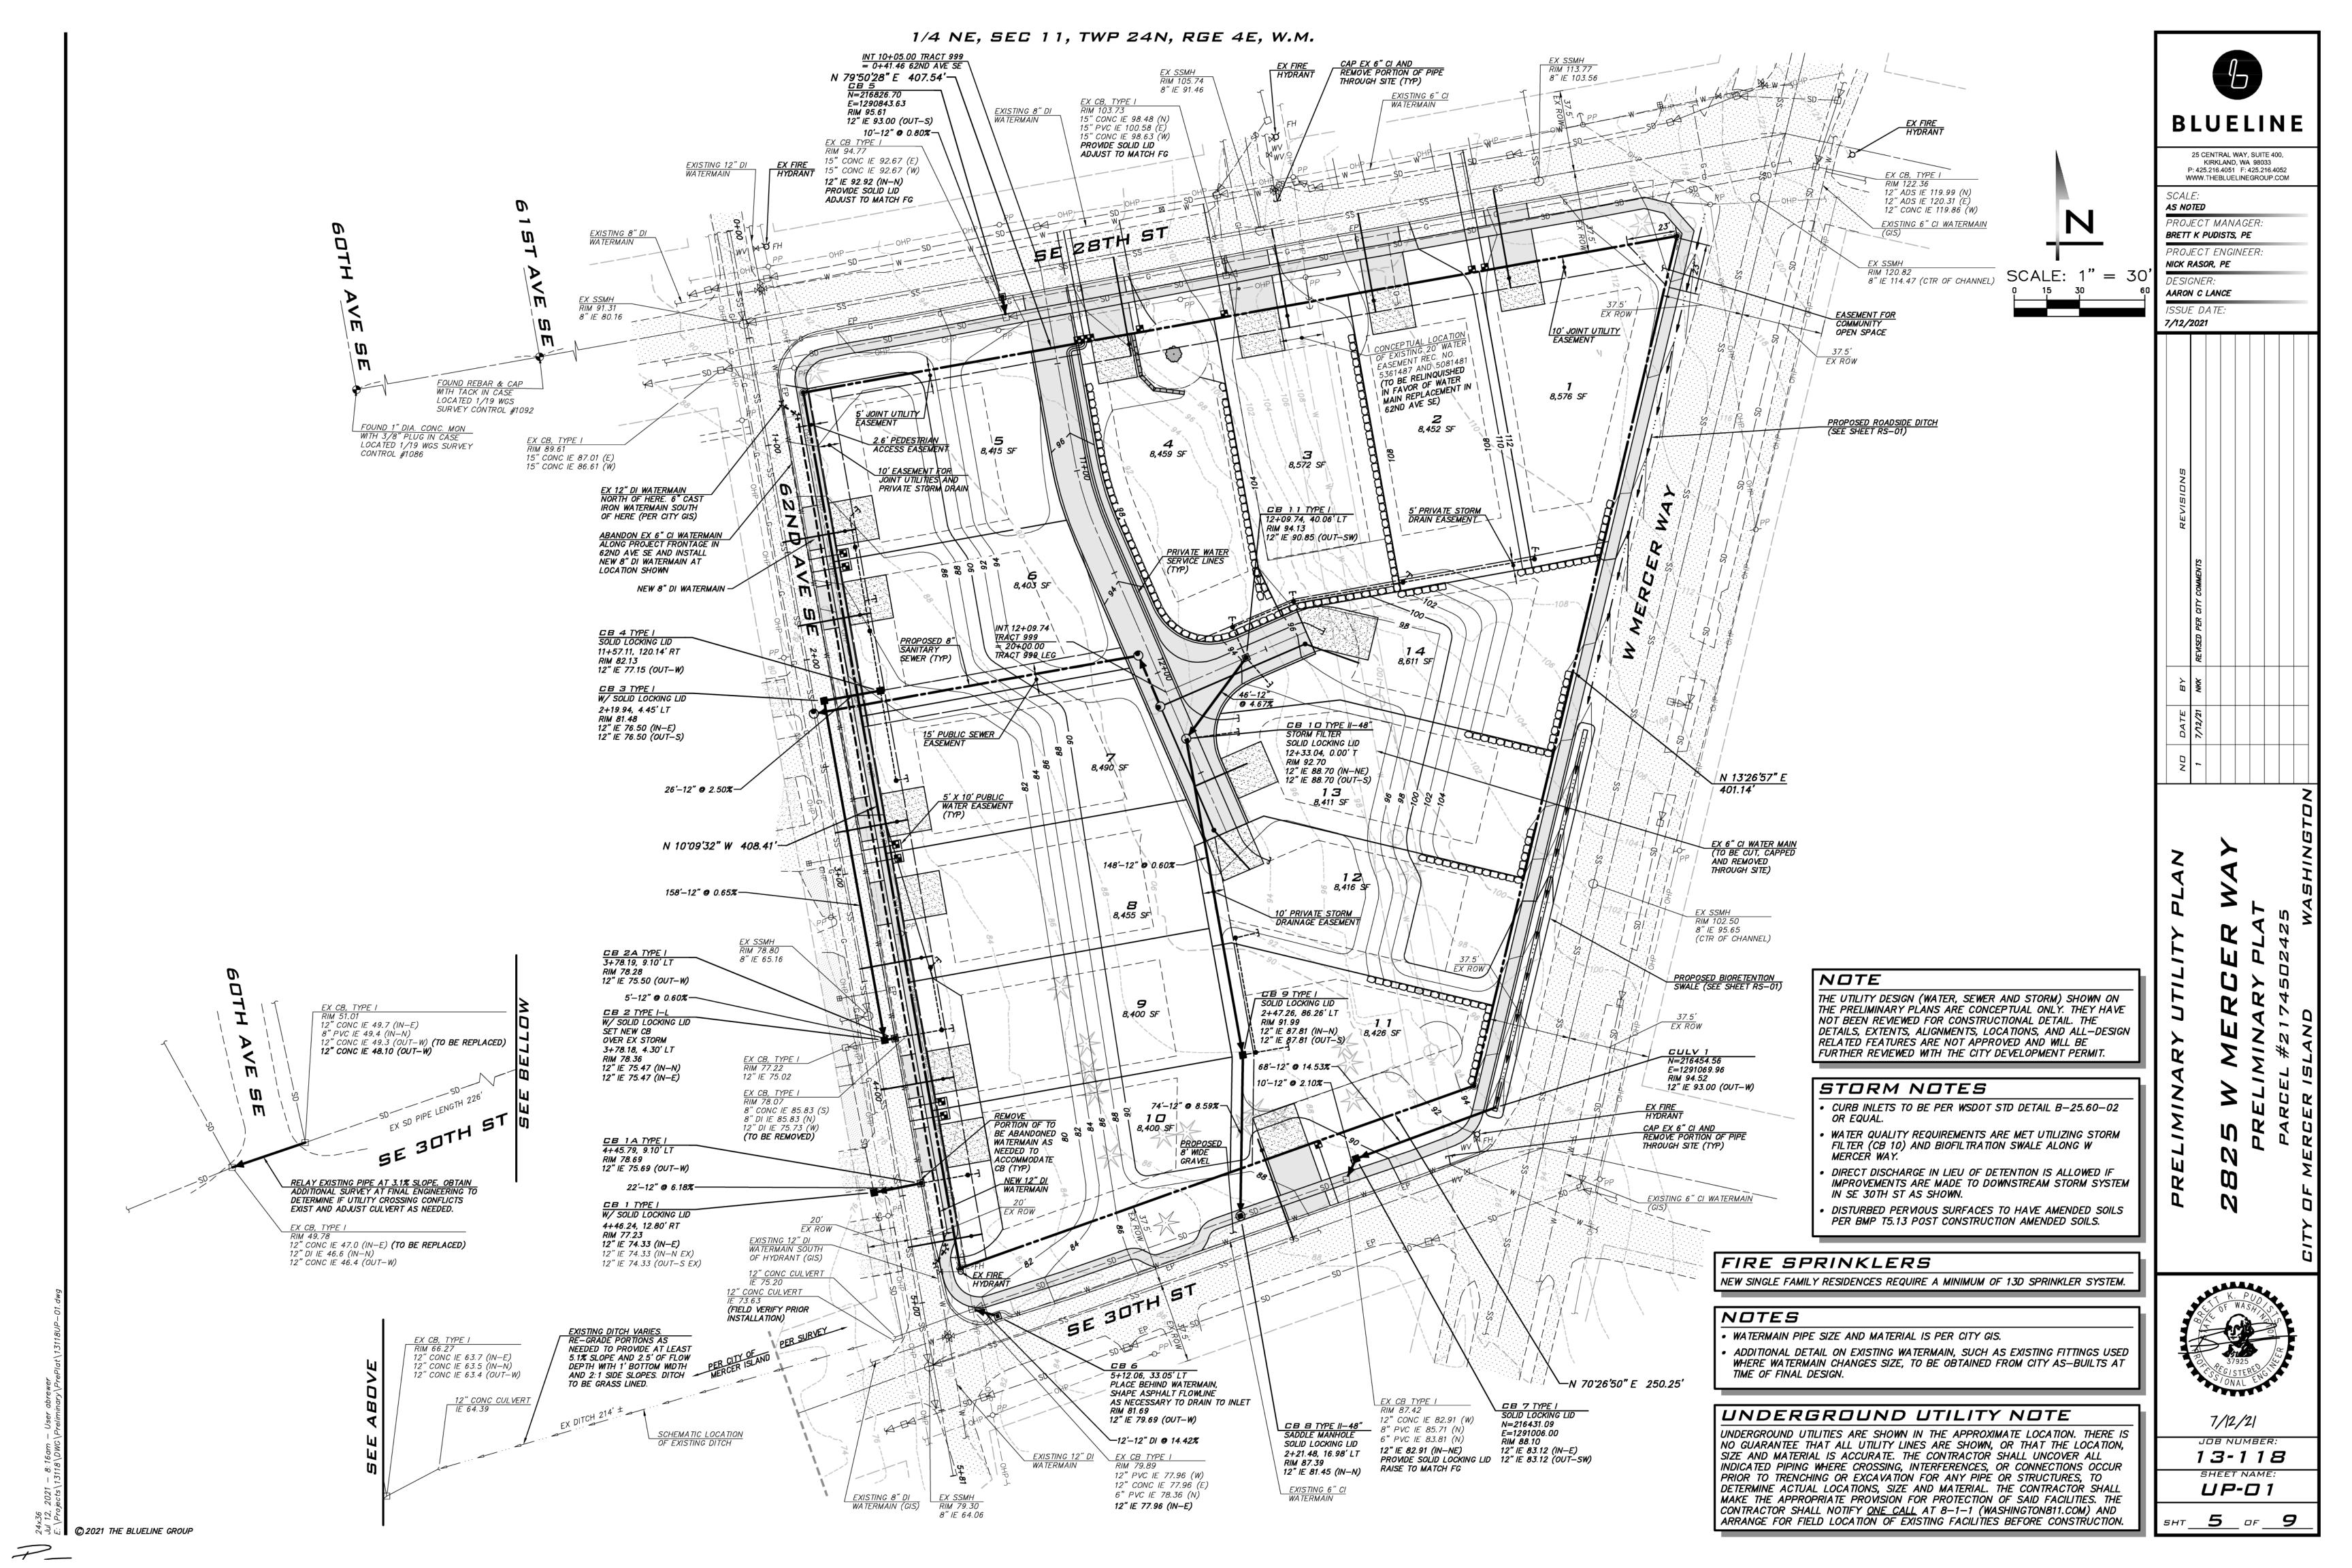
6,100 CY

NOTE: QUANTITIES ARE PRELIMINARY AND WERE CALCULATED BY SUBTRACTING FINISHED GRADE FROM EXISTING GRADE.

- AS DESIGNED, NO AREAS EXCEED 6' OF CUT OR FILL.
- PAD ELEVATIONS ARE APPROXIMATE AND WILL BE REFINED DURING FINAL DESIGN WHEN PROPOSED BUILDING PLANS ARE KNOWN.
- TESC FACILITIES TO BE DESIGNED DURING FINAL ENGINEERING TO PREVENT SEDIMENT LADEN RUNOFF FROM LEAVING THE SITE.

UNDERGROUND UTILITY NOTE

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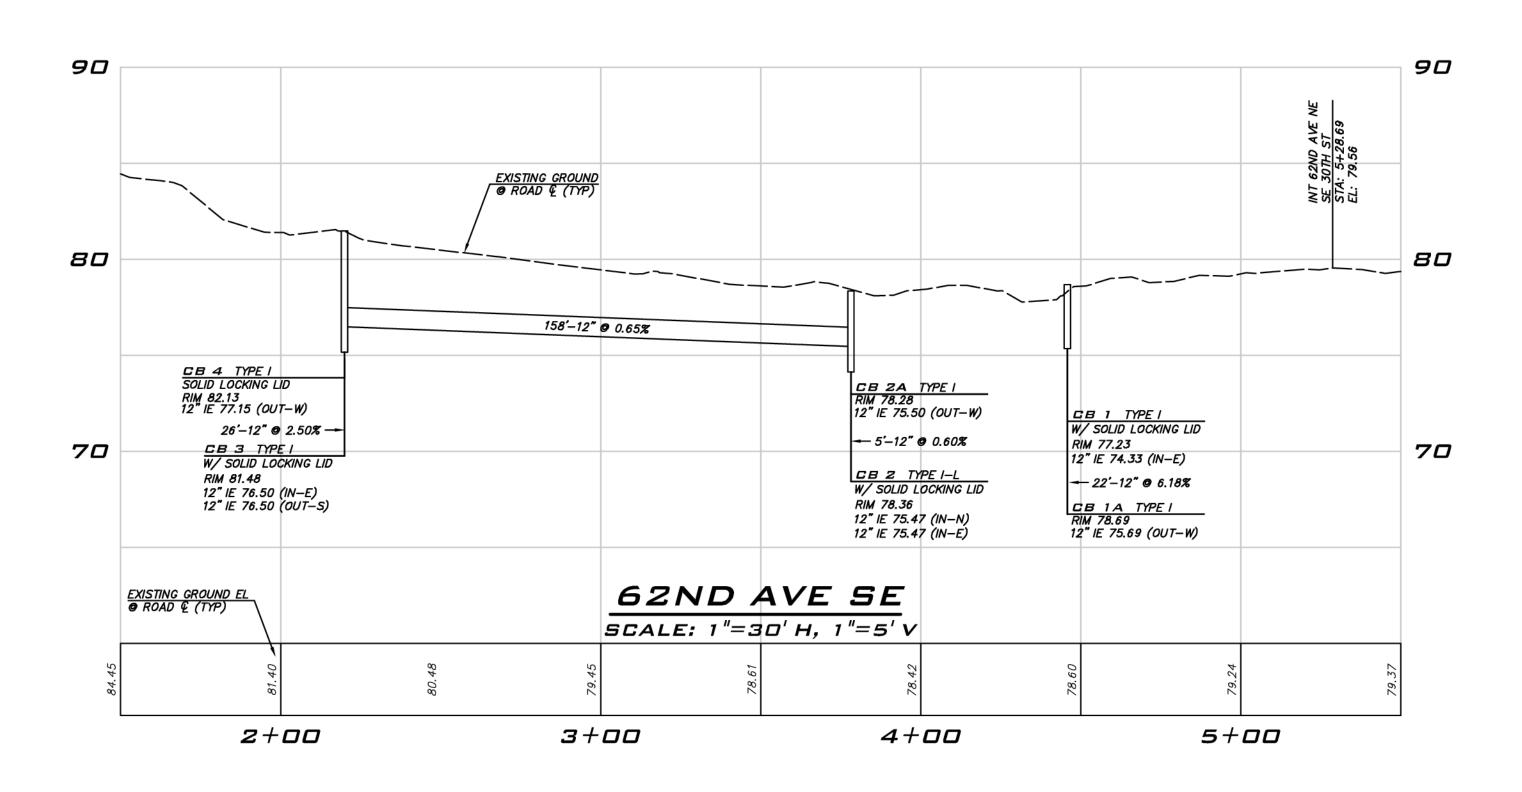
BRETT K PUDISTS, PE PROJECT ENGINEER: NICK RASOR, PE

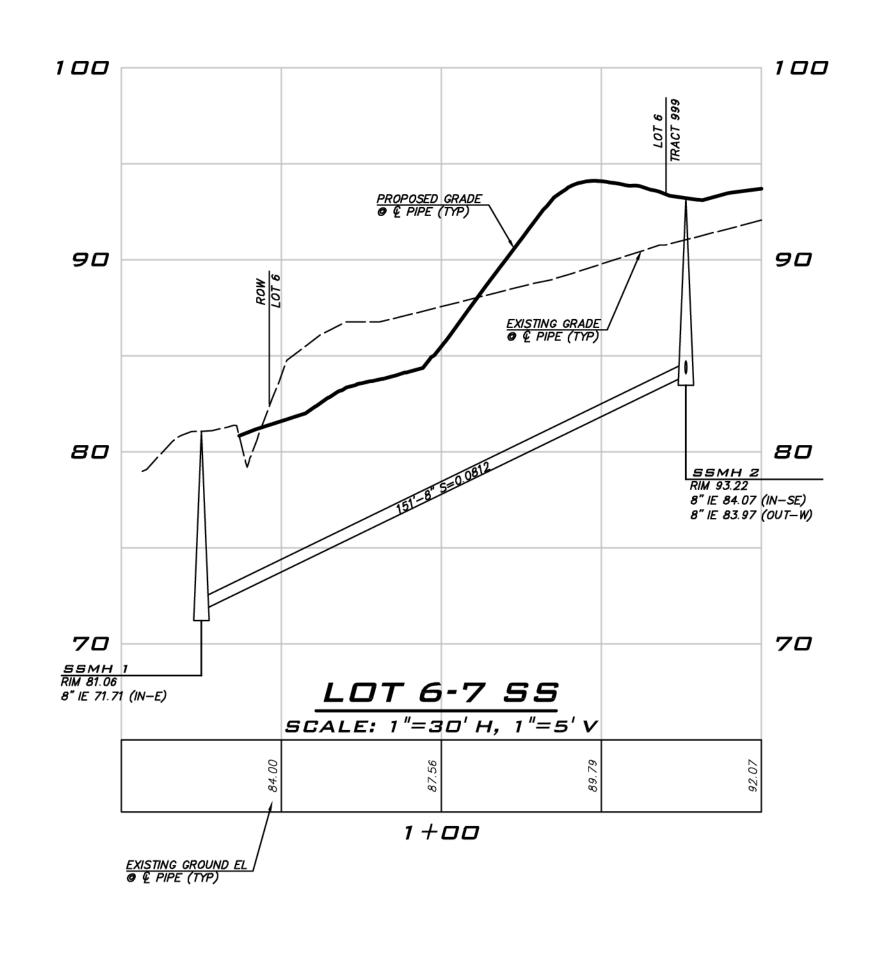
AARON C LANCE ISSUE DATE:

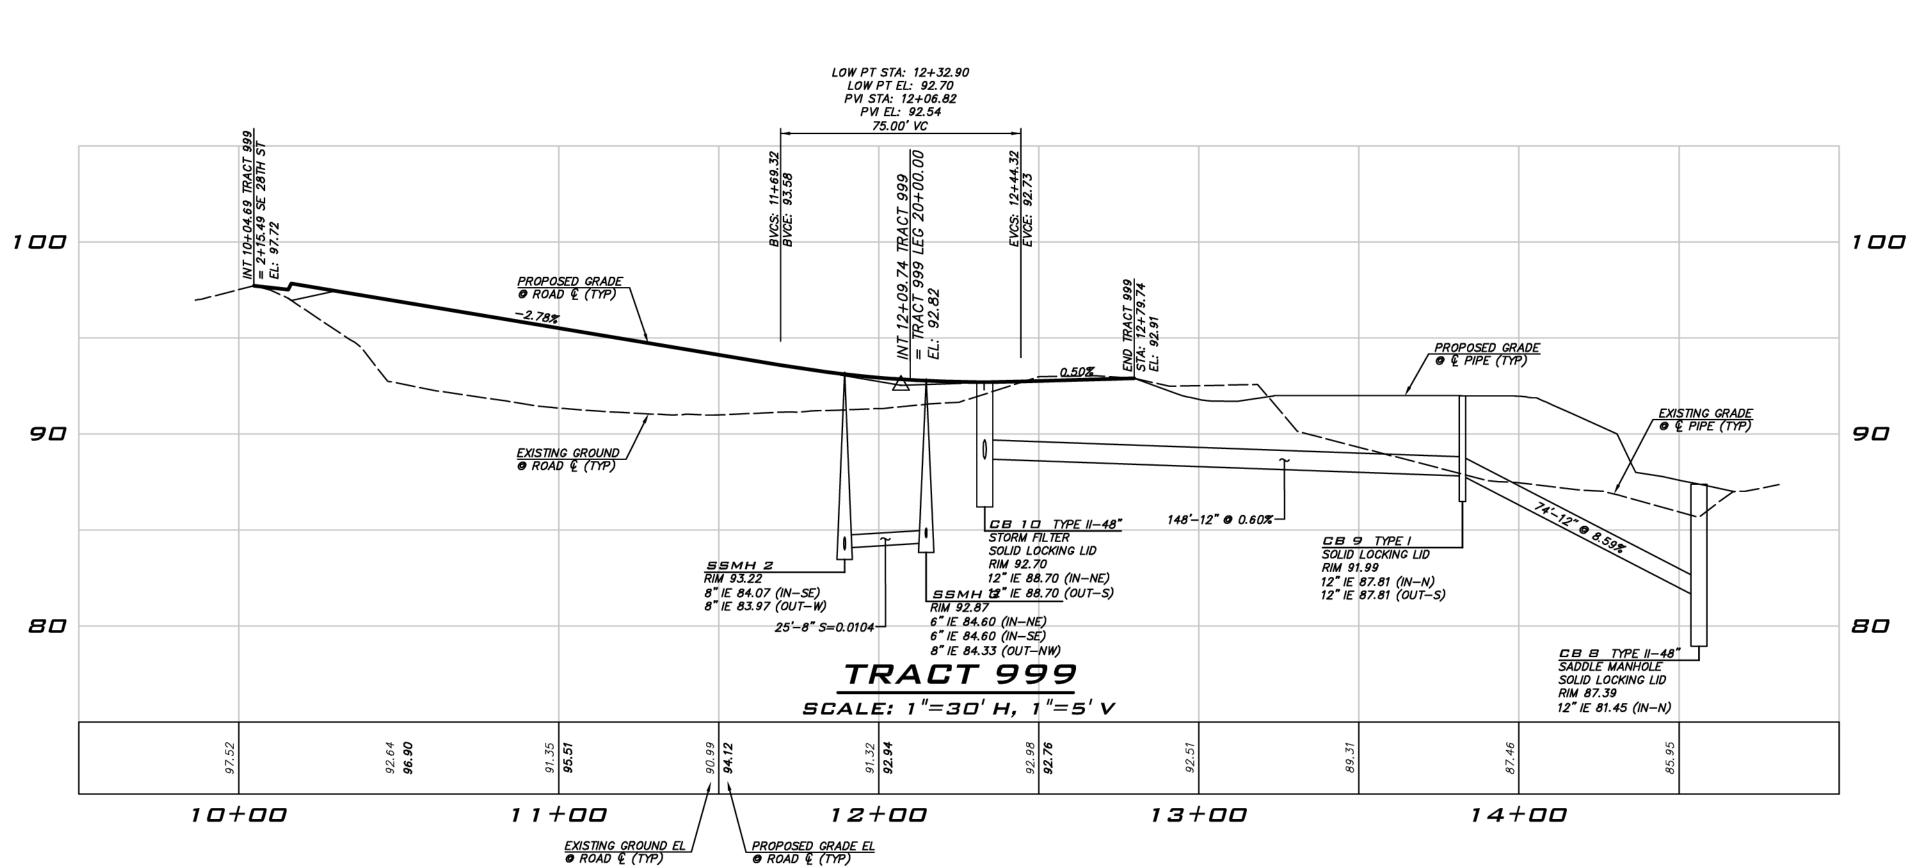
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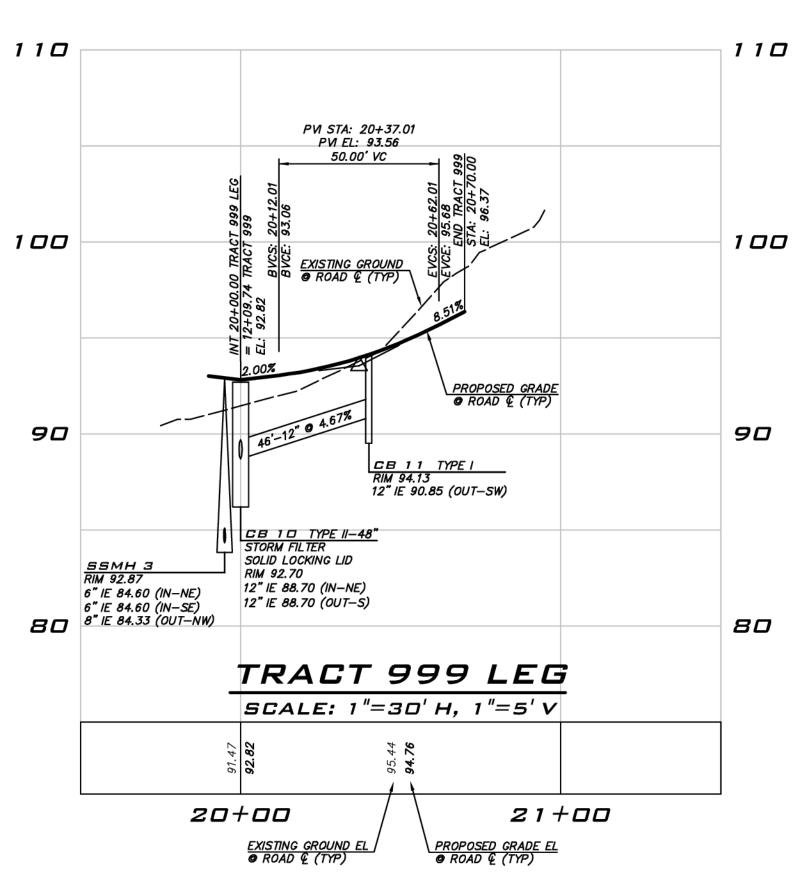
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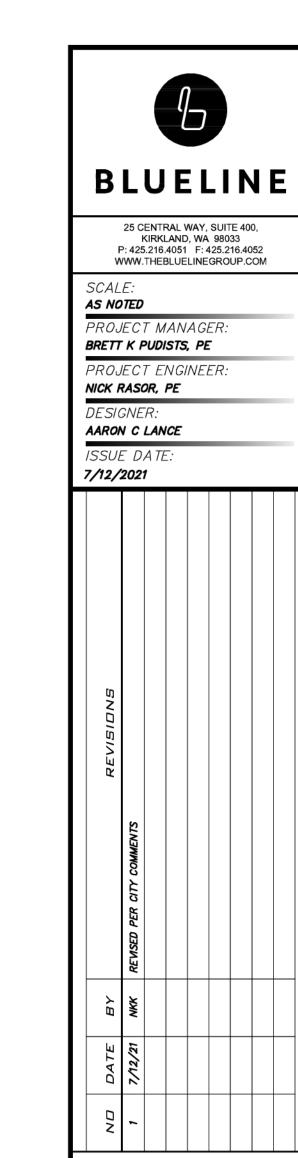


NOTE

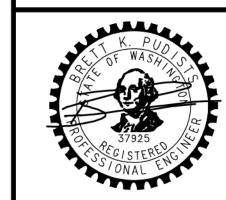
NO DIRECT VEHICULAR ACCESS TO W MERCER WAY.

UNDERGROUND UTILITY NOTE

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2825 W MERCER WAY
PRELIMINARY PLAT
PARCEL #2174502425



7/12/21

JOB NUMBER:
13-118
SHEET NAME:
RP-01

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PROJECT MANAGER: BRETT K PUDISTS, PE

NICK RASOR, PE

AARON C LANCE ISSUE DATE:

7/12/21

13-118 SHEET NAME: TR-0 1

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Attachment No. 3 – Regulated Tree Inventory (Boldface tree to be retained)

Regulated Threshold	Regulated Category	≥ 24" DBH	Tree No.*	DBH (In.)	QMD	Common name/Latin name	Dripline Radius	Health	Structure	Comments on Condition	Тгее Туре	Tree?
36"	Significant		1	9,16"	18"	Empress tree, Paulownia tomentosa	20'	1	2	Asymmetric canopy	D	No
6"	Exceptional	Yes	2	27"		Madrone, Arbutus menziesii	16′	1	1		BE	Ye
16"	Significant		3	7,7,8,9"	15"	English hawthorn, Crataegus monogyna	12'	2	3	Diseased, stumpsprout	D	No
16"	Exceptional		4	16"		English hawthorn, Crataegus monogyna	15'	2	3	Topped, double leader, over mature	D	No
21"	Exceptional		5	16,16"	23"	Blireiana flowering plum, Prunus blireiana	16'	2	3	Double leader, over mature	D	N
21"	Significant		6	20"		Blireiana flowering plum, Prunus blireiana	16'	2	3	Over mature	D	N
21"	Significant		7	8"		Blireiana flowering plum, Prunus blireiana	15'	2	3	Over mature	D	N
21"	Significant		8	14"		Blireiana flowering plum, Prunus blireiana	14'	3	3	Suckers, over mature, fungal conks on trunk	D	N
16"	Significant		9	8,8,10"	15"	English hawthorn, Crataegus monogyna	18'	2	3	Diseased, topped, stumpsprout	D	N
21"	Significant		10	12"		Blireiana flowering plum, Prunus blireiana	14'	3	з	8.	D	N
21"	Significant		11	12"		Blireiana flowering plum, Prunus blireiana	7'	3	3	Diseased, branch decline, decay	D	N
21"	Significant		12	20"		Blireiana flowering plum, Prunus blireiana	16'	3	з	decay	D	N
21"	Significant		13	11"		Blireiana flowering plum, Prunus blireiana	12'	1	3	Root failure	D	N
21"	Significant		14	11"		Blireiana flowering plum, Prunus blireiana	16'	2	2	Over mature, roots at soil surface	D	N
NR			16	21"		Leyland cypress, Cupressus xLeylandii	16'	1	2	A	С	N
NR			17	12,14"	18"	Leyland cypress, Cupressus xLeylandii	13'	1	2	Asymmetric (hedge against	С	N
NR		Yes	18	24"		Leyland cypress, Cupressus xLeylandii	15'	1	2	existing building)		N

Registered Consulting Arborist

Mike O'Brien, OB Mercer Island Properties
RE: Arborist Report, 2825 West Mercer Way, Mercer Island WA
February 21, 2019

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Regulated Threshold	Regulated Category	> 24" DBH	Tree No.*	DBH (In.)	QMD	Common name/Latin name	Dripline Radius	Health	Structure	Comments on Condition	Тгее Туре	Viable Tree?
NR			19	12"		Leyland cypress, Cupressus xLeylandii	16'	1	2		С	No
NR		Yes	20	28"		Leyland cypress, Cupressus xLeylandii	16'	1	2		С	No
NR		Yes	21	27"		Leyland cypress, Cupressus xLeylandii 16' 1 2			С	No		
NR		Yes	22	34"		Leyland cypress, Cupressus xLeylandii	16'	1	2		С	No
NR			23	21"		Leyland cypress, Cupressus xLeylandii	16'	1	2		С	No
NR		Yes	24	26"		Leyland cypress, Cupressus xLeylandii	16'	1	2		С	No
NR		Yes	25	18,21"	27"	Leyland cypress, Cupressus xLeylandii	16'	1	1		С	Yes
NR		Yes	26	25"		Leyland cypress, Cupressus xLeylandii	16'	1	2		С	No
NR		Yes	27	24"		Leyland cypress, Cupressus xLeylandii	16'	1	2	Asymmetric (hedge against	С	No
NR		Yes	28	31"		Leyland cypress, Cupressus xLeylandii	16'	1	2	existing building)	С	No
NR			29	11"		Portugal laurel, Prunus lusitanica	10'	1	1		BE	Yes
36"	Significant		30	8,8"	11"	Plum (seedling), Prunus domestica	15'	3	3	Diseased, topped, decay, lean	D	No
36"	Significant		31	14"		Pear, common, Pyrus communis	16'	2	3	Topped, covered in ivy	D	No
16"	Significant		32	8,8,8"	13"	English hawthorn, Crataegus monogyna	15'	2	3	Multiple Idrs, lean, ivy	D	No
NR			33	7,9"	11"	Portugal laurel, Prunus Iusitanica	12'	1	2	Double leader	BE	Yes

NR = Not Regulated

Tree numbers are non-sequential because 3 *small* trees included in the previous inventory are removed from this report.

Greenforest	•	Registered Consulting Arborist

CITY OF MERCER ISLAND COMMUNITY PLANNING & DEVELOPMENT 9611 SE 36TH STREET | MERCER ISLAND, WA 98040 PHONE: 206.275.7605 | www.mercergov.org

Number of Large Regulated Trees in right of way

Number of Large Regulated Trees in right of way proposed for removal

List tree numbers:

EXCEPTIONAL TREES



TREE INVENTORY & REPLACEMENT SUBMITTAL INFORMATION

<u>Exceptional Trees</u> - means a tree or group of trees that because of its unique historical value constitutes an important community resource. A tree that is rare or exception species, condition, cultural/historical importance, age, and/or contribution as part of a diameter of more than 36 inches, or with a diameter that is equal to or greater that the Exceptional Tree Table shown in MICC 19.16 under Tree, Exceptional.	nal by virtue of a tree grove. Tre	its size, ees with
List the total number of trees for each category and the tree identification numbers f	rom the arborist	report.
Number of trees 36" or greater	0	
List tree numbers:		
Number of trees 24" or greater (including 36" or greater)	1	
List tree numbers: 2		
Number of trees from Exceptional Tree Table (MICC 19.16)	0	
List tree numbers:		
LARGE REGULATED TREES		
<u>Large Regulated Trees</u> - means any tree with a diameter of 10 inches or more, and definition of an Exceptional Tree.	any tree that me	eets the
Number of Large Regulated Trees on site	1	(A)
List tree numbers:		
Number of Large Regulated Trees on site proposed for removal	0	(B)
List tree numbers:		
Percentage of trees to be retained ((A-B)/Ax100) note: must be at least 30%	100	%
RIGHT OF WAY TREES		
Right of Way Trees- means a tree that is located in the street right of way adjacent t	to the project pr	operty.

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List tree numbers:			
Reason for removal:			

Tree replacement- removed trees must be replaced based on the ratio in the table below. Replacement trees shall be conifers at least six feet tall and or deciduous at least one and one-half inches in diameter at base.

			Number of free
	Tree	Number of	Required for
Diameter of Removed Tree (measured 4.5'	replacement	Trees Proposed	Replacement Based
above ground)	Ratio	for Removal	on Size/Type
Less than 10" and non-viable trees	1	13	13
10" up to 24"	2	0	0
Greater than 24" up to 36"	3	0	0
Greater than 36" and any Exceptional Tree	6	2	12
	TOTAL TRE	25 required	

37 provided

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SCALE: AS NOTED

PROJECT MANAGER: BRETT K PUDISTS, PE

PROJECT ENGINEER: NICK RASOR, PE

DESIGNER: AARON C LANCE

ISSUE DATE: 7/12/2021

7/12/21 NKK REVISED PER CITY COMMENTS

A T 25

KUEK W KRY PLAT74502425

PRELIMINARY F

K. PUO WASHINGS 37925 37925 CONAL ENGLISHED

7/12/2

13-118 SHEET NAME: TR-02

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